



CHIMNEY AND VALLEY GUTTER DETAIL (SIDE ELEVATION)

Scale: 1:20

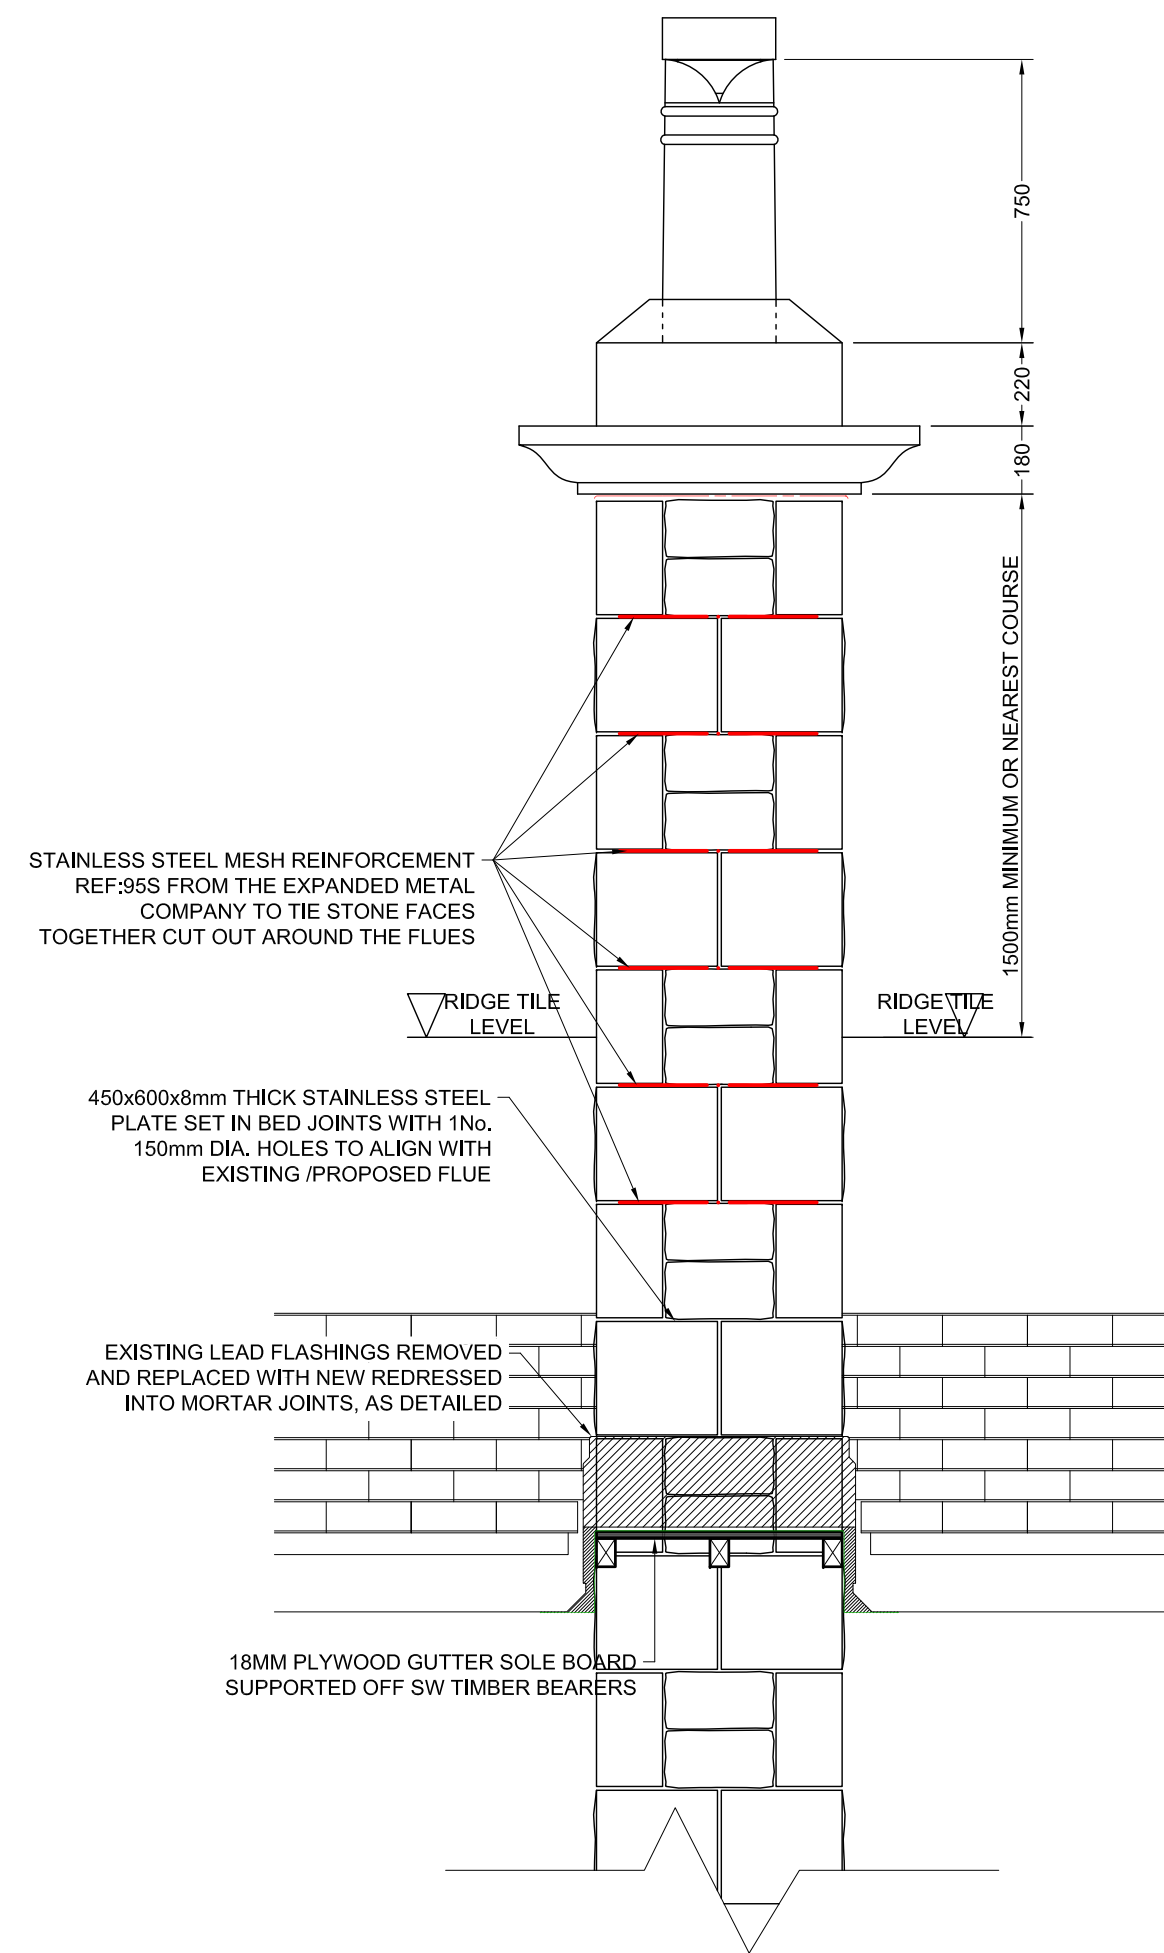


FRONT ELEVATION

Scale: 1:20

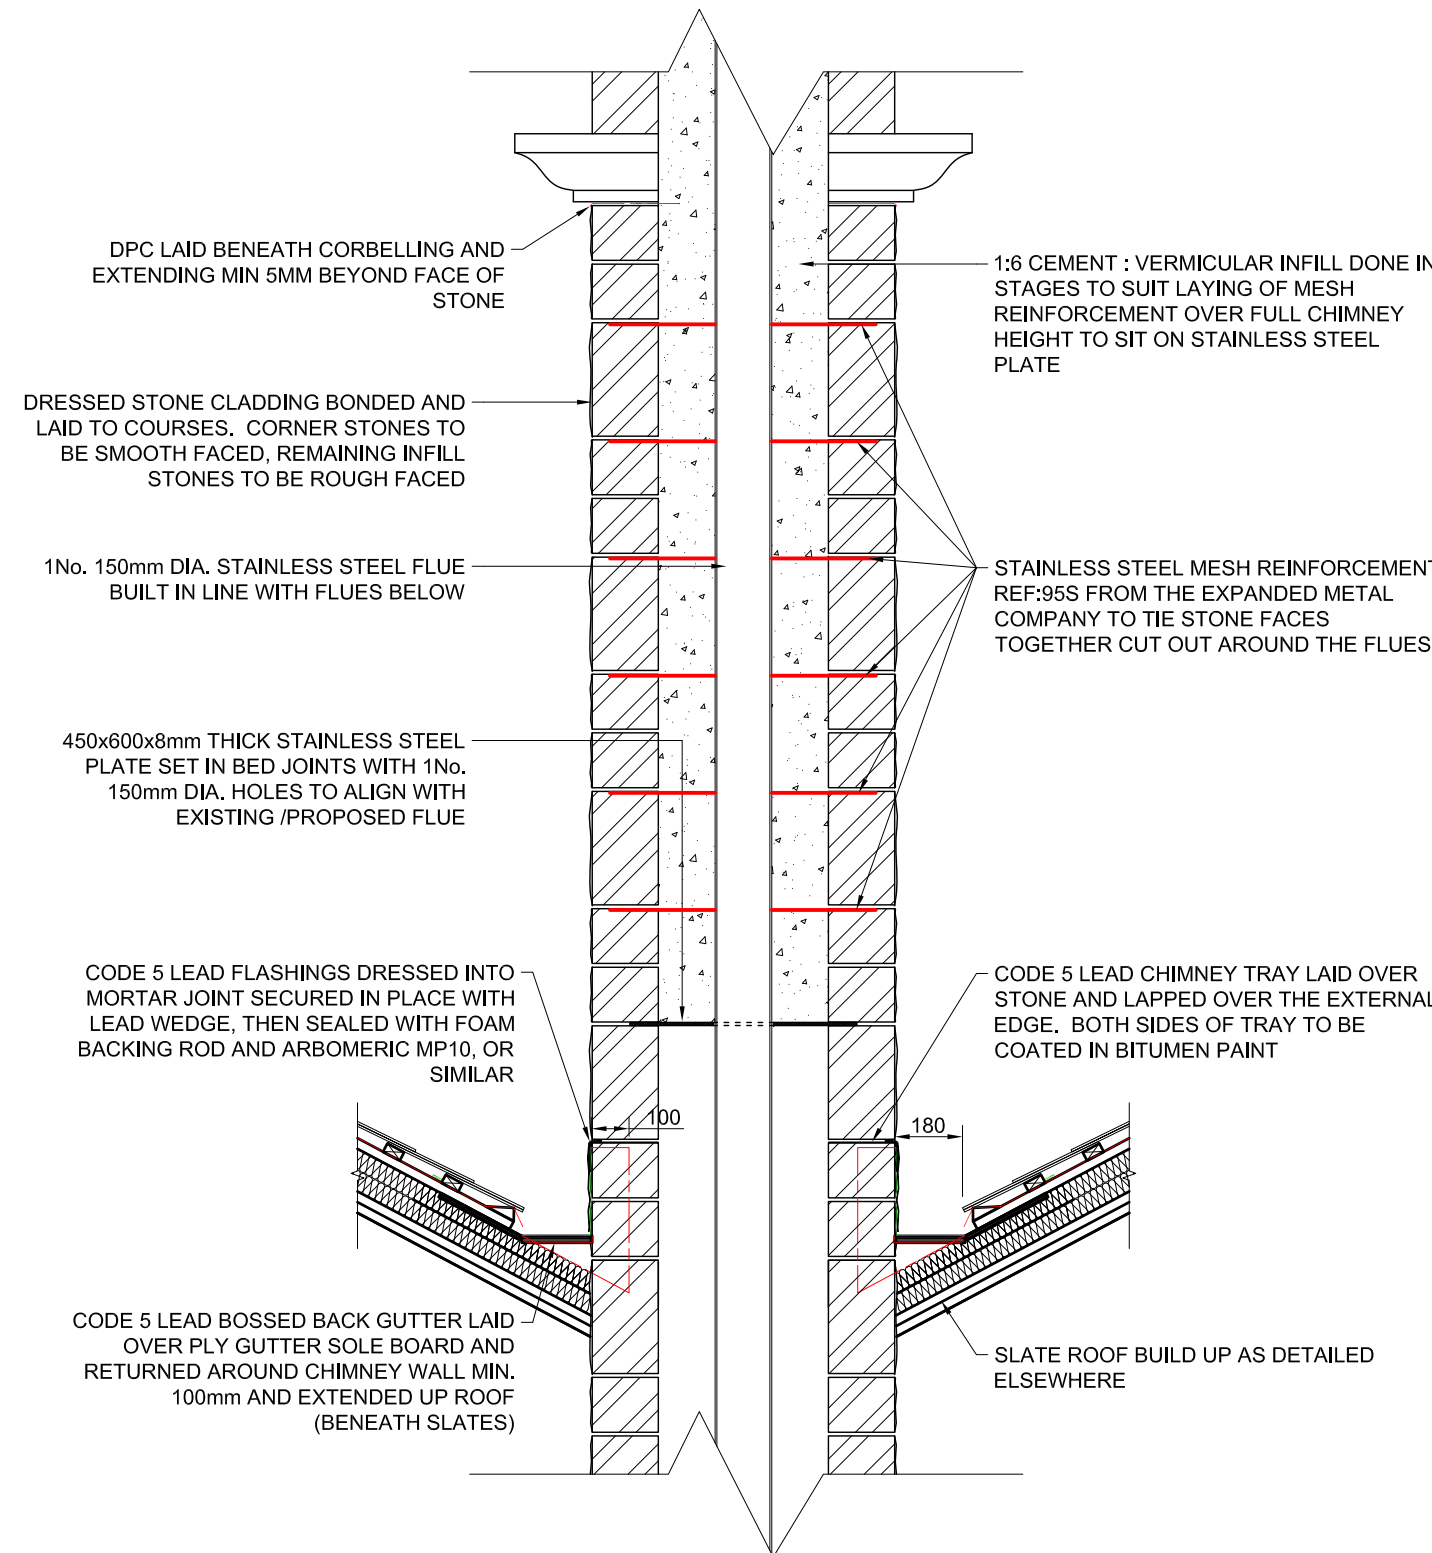


SECTION B-B - THROUGH CHIMNEY BACK GUTTERS

Scale: 1:20

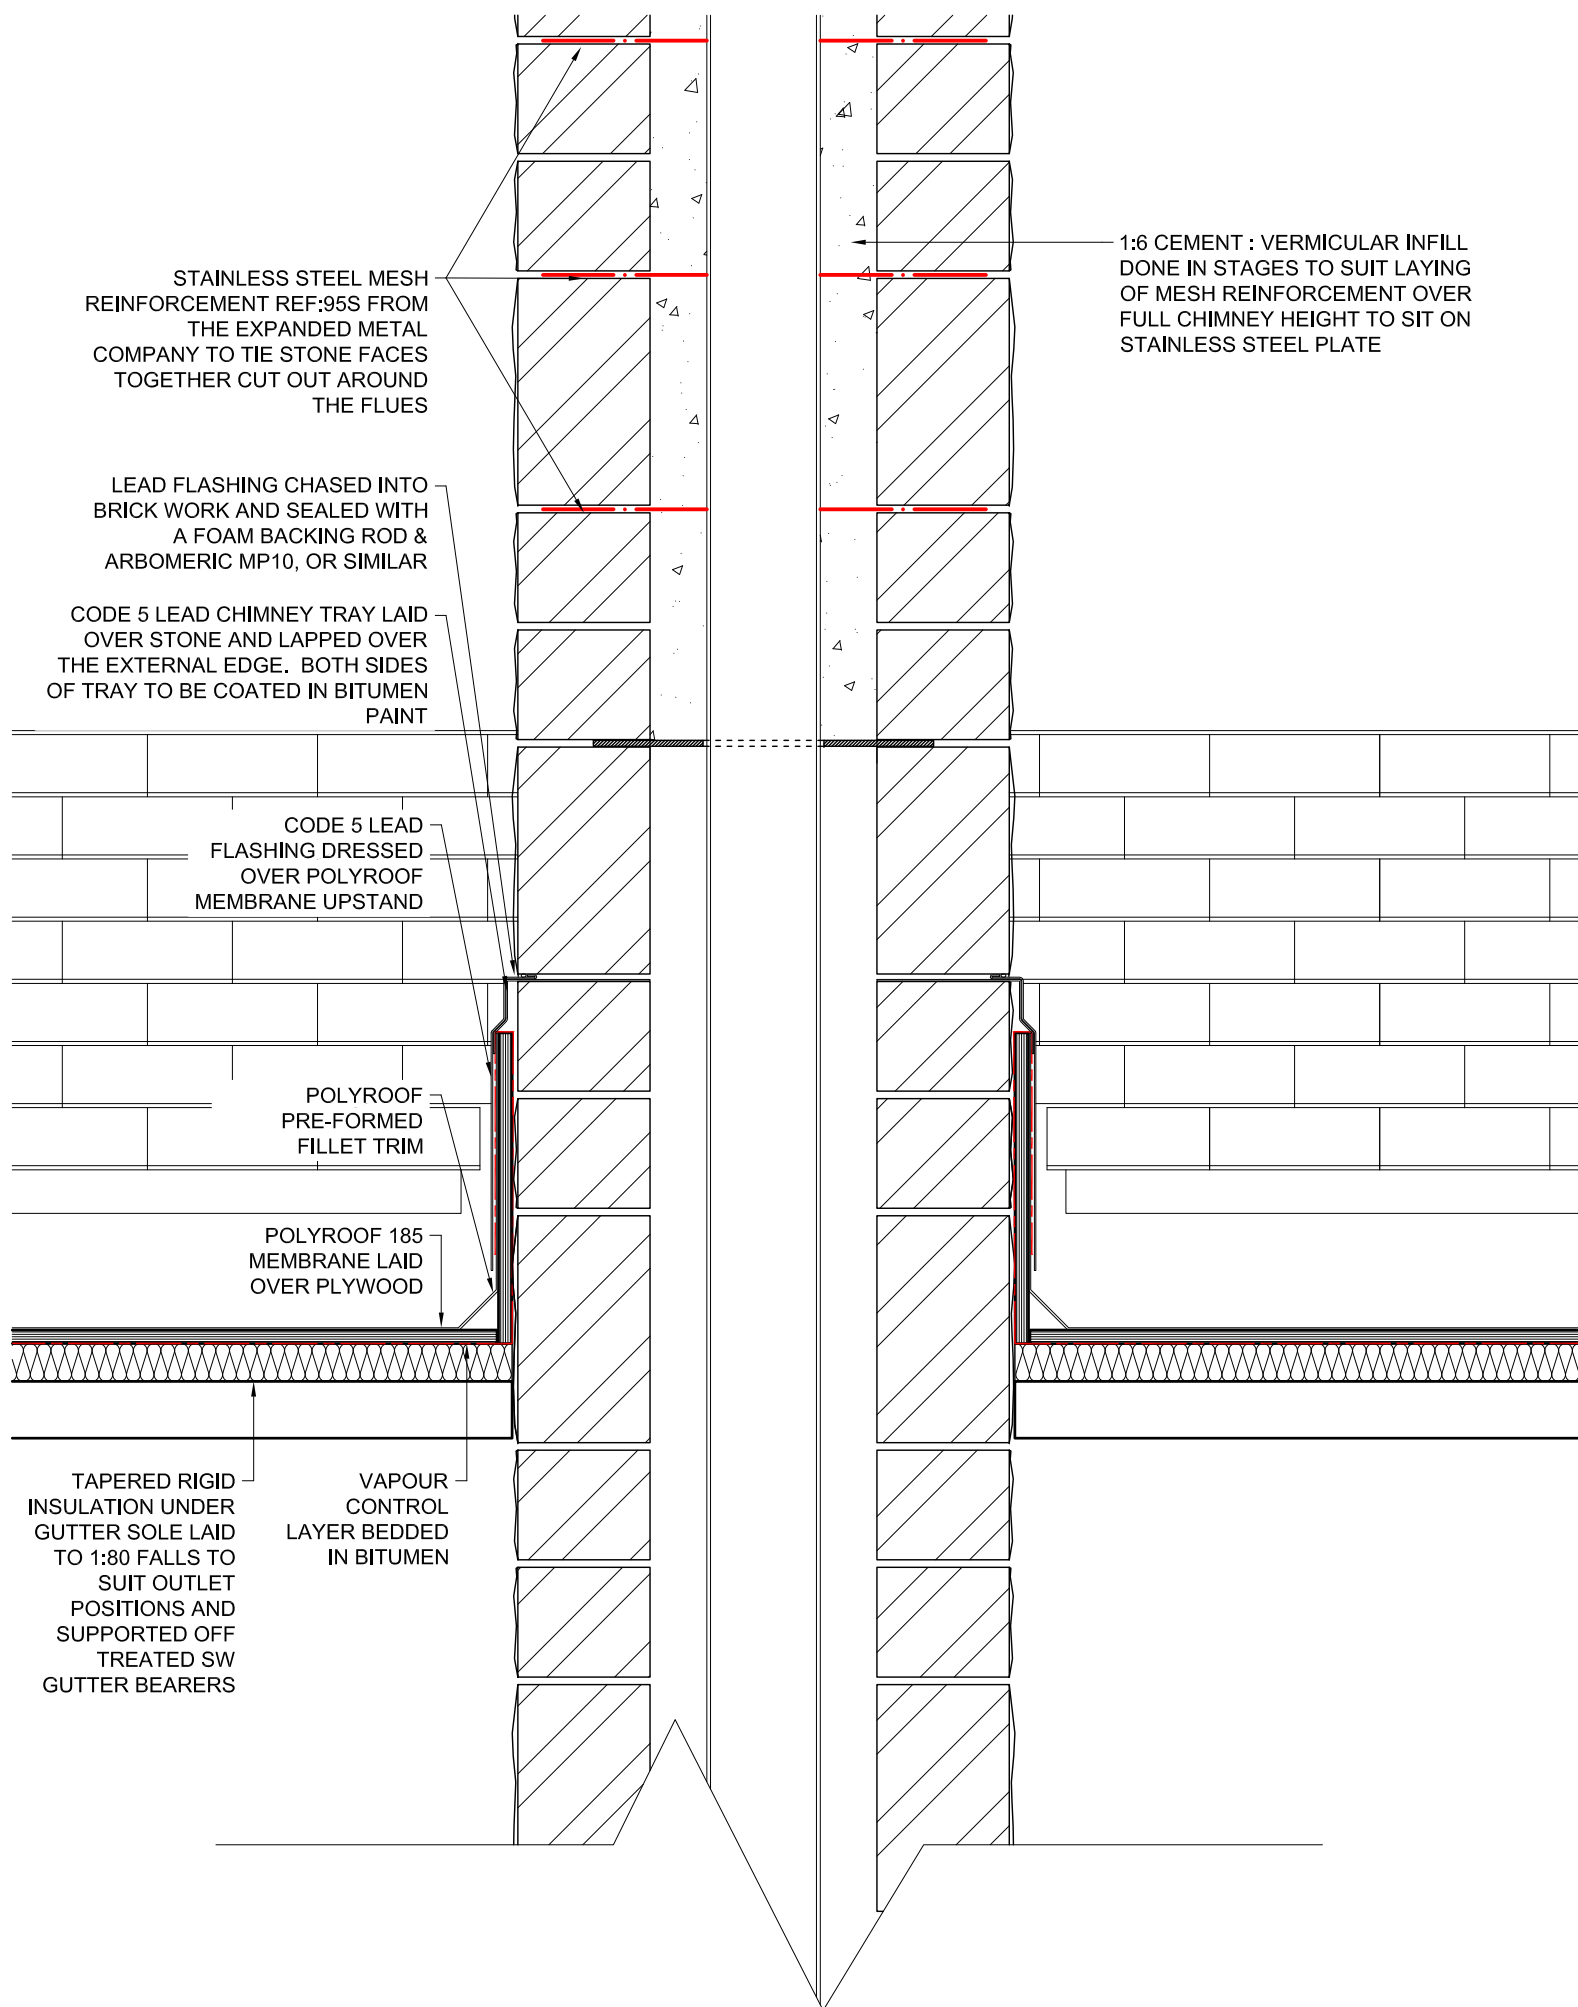


SECTION C-C - THROUGH CHIMNEY GUTTER LEVEL

Scale: 1:10

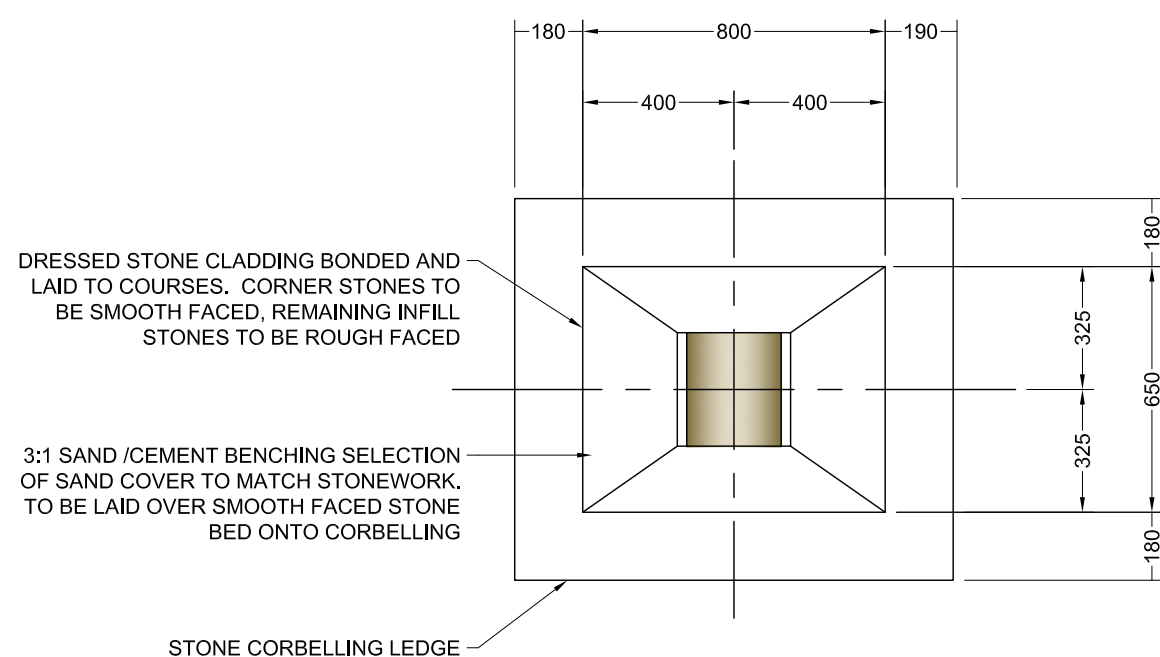

SINGLE CHIMNEY STACK PLAN

Scale: 1:20

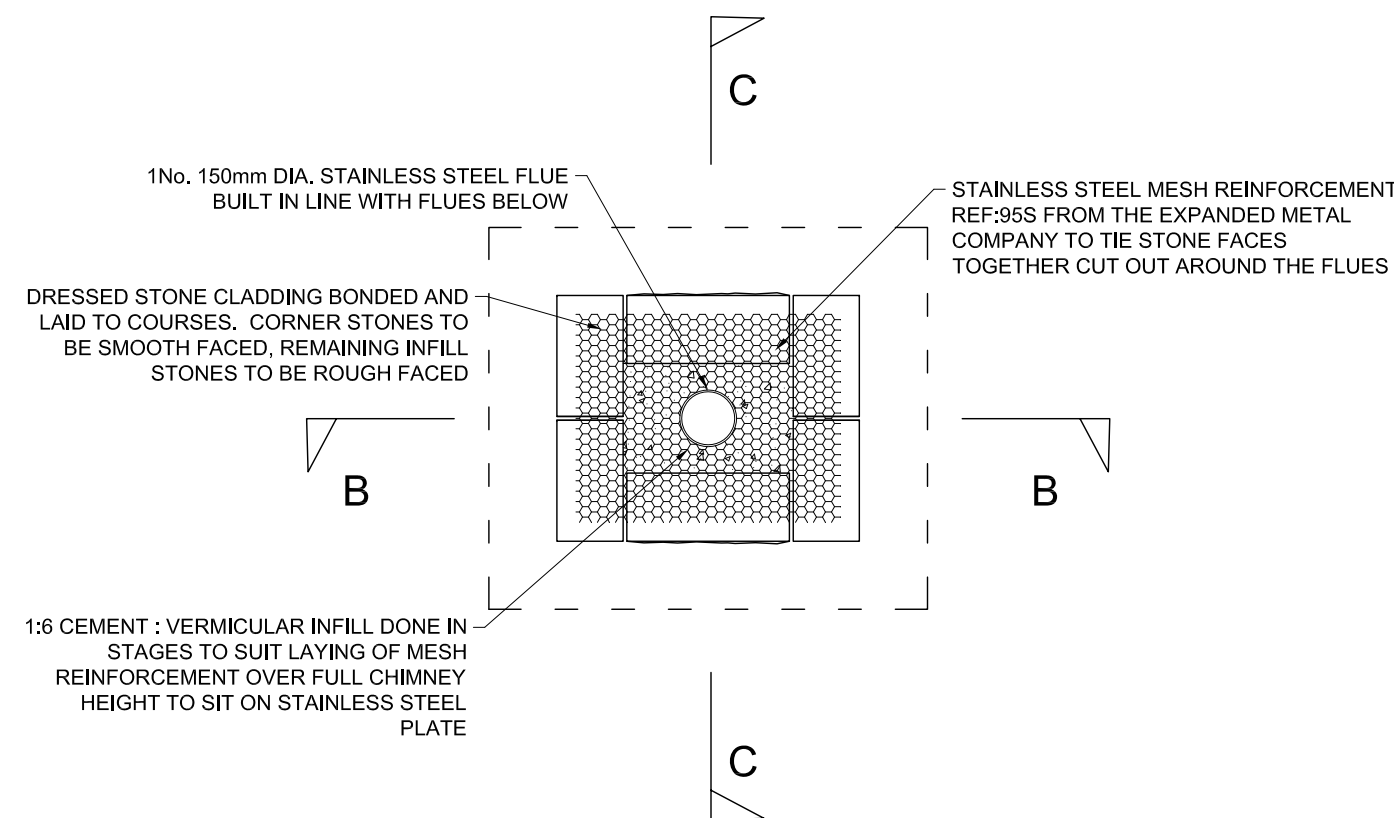

SECTION A-A - THROUGH CHIMNEY STACK

Scale: 1:20

- SANDSTONE SHALL BE LOCALLY SOURCED AND SHALL BE OF COLOUR, TYPE AND TEXTURE TO MATCH THE EXISTING STONE.
- STONE TO BE BONDED AND POINTED WITH LIME MORTAR.
- 100MM THICK LAYER OF GRADE C10 CONCRETE TO BE PLACED ON TOP OF MS PLATES. SAND/CEMENT INFILL SHALL BE PLACED AT LEAST 24Hrs FOLLOWING PLACEMENT OF C10 CONCRETE.

Legend/Notes	
THIS DRAWING IS TO BE READ WITH AND FORMS PART OF THE PROJECT DOCUMENTS LISTED BELOW	
DOCUMENTS:	NON-COMPLEX DESIGN PACKAGE
BDG0069/CI/NCC	EXISTING SITE & LOCATION PLANS
BDG0069/DRG/A001	EXISTING & PROPOSED ELEVATIONS
BDG0069/DRG/A002	GENERAL ARRANGEMENT PLANS
BDG0069/DRG/A003	REPAIR WORKS PLANS
BDG0069/DRG/A004	EXISTING & PROPOSED TYPICAL SECTIONS
BDG0069/DRG/A005	TYPICAL DETAILS SHEET 1 OF 3
BDG0069/DRG/A006	TYPICAL DETAILS SHEET 2 OF 3
BDG0069/DRG/A007	TYPICAL DETAILS SHEET 3 OF 3
BDG0069/DRG/A008	PROPOSED TRIPLE CHIMNEY STACK REPLACEMENT
BDG0069/DRG/A009	PROPOSED SINGLE CHIMNEY STACK REPLACEMENT
BDG0069/DRG/A010	ELECTRICAL LAYOUT / DETAILS
BDG0069/DRG/E001	NBS SPECIFICATION
BDG0061/CI/SPEC/A01	NBS SPECIFICATION
MODEL CLAUSES:	
NRL/3/CI/140/10	GENERAL
NRL/3/CI/140/40	DEMOLITION AND SITE CLEARANCE
NRL/3/CI/140/80	STRUCTURAL CONCRETE
RT/CE/C/008/150	BRICKWORK, BLOCKWORK & MASONRY
RT/CE/C/008/153	BRICKWORK & MASONRY REPAIRS
NRL/3/CI/140/160	GENERAL REQUIREMENTS FOR STRUCTURAL TIMBER
NRL/3/CI/140/161	DESIGN REQUIREMENTS FOR STRUCTURAL TIMBER
NRL/3/CI/140/162	WORKMANSHIP FOR STRUCTURAL TIMBER
NRL/3/CI/140/163	MAINTENANCE AND REPAIR OF STRUCTURAL TIMBER
NRL/3/CI/140/164	TIMBER PRESERVATION AND FIRE PROTECTION
NRL/3/CI/140/170	GENERAL REQUIREMENTS FOR PROTECTIVE TREATMENTS
NRL/3/CI/140/171	MAINTENANCE COATING WORKS
NRL/3/CI/140/173	PROTECTIVE COATING OF EXISTING STRUCTURAL STEELWORK AND IRONWORK
NRL/3/CI/140/174	PROTECTIVE COATING OF TIMBER SURFACES
NRL/3/CI/140/175	PROTECTIVE COATING OF CONCRETE & MASONRY SURFACES
NRL/3/CI/140/176	PROTECTIVE COATING SYSTEMS

GENERAL NOTES:

- ALL WORKS TO BE UNDERTAKEN IN ACCORDANCE WITH CURRENT AND APPLICABLE RAILWAY GROUP AND NETWORK RAIL LINE STANDARDS.
- ALL DIMENSIONS ARE SHOWN IN MILLIMETRES UNLESS NOTED OTHERWISE.
- USE ONLY DIMENSIONS STATED ON THE DRAWINGS DO NOT TAKE SCALED DIMENSIONS.
- ALL LEAD FLASHING, SOAKERS, STEPPED FLASHING, COVER FLASHING, APRON FLASHING, CHIMNEY FLASHING, PITCHED VALLEYS ETC. TO BE CARRIED OUT IN ACCORDANCE WITH THE LEAD SHEET ASSOCIATION DETAILING.



SCALE 1:10



SCALE 1:20

A01	16/07/2010	ISSUED FOR NON-COMPLEX WORK	DPC	JW	JW
Rev	Date	Description of Revisions	Drawn	Chkd	Appr

SAFETY HEALTH AND ENVIRONMENTAL INFORMATION

THE HAZARDS AND RISKS ASSOCIATED WITH THE WORKS SHOWN ON THIS DRAWING AND DESCRIBED IN THE SCHEDULE OF WORKS ARE CONSIDERED TO BE WITHIN THE REASONABLE, NORMAL AND ACCEPTABLE LIMITS FOR GENERAL BUILDING AND MAINTENANCE WORKS. PLEASE REFER TO DESIGNER RISK ASSESSMENT

DOCUMENT REF: BDG0069/DRA/A01

FOR ISSUE NON COMPLEX WORKS



INVESTMENT PROJECTS  
BUILDINGS & CIVILS  
SQUARE ONE  
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M1 2NY

Designers  
Investment Projects  
Buildings & Civils  
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Project BDG0069

BUXTON STATION  
DPC/DRY ROT REPAIRS, STATION  
ROOF & CANOPY ROOF REPAIRS

PROPOSED SINGLE CHIMNEY STACK REPLACEMENT

Designer	A.WADIE	Signed	Date	JULY 2010
Drawn	D.CARVER	Signed	Date	14/07/2010
Checked	J.WILDGOOSE	Signed	Date	15/07/2010
Approved	J.WINSTANLEY	Signed	Date	16/07/2010

Scale(s) at A1 Sheet Size A1 594 x 841 ELR & Mileage  
1:10, 1:20 BEJ 19 MILES 9 CHAINS

Drawing Number	Revision
BDG0069/DRG/A010	A01