



CHIMNEY AND VALLEY GUTTER DETAIL (SIDE ELEVATION)

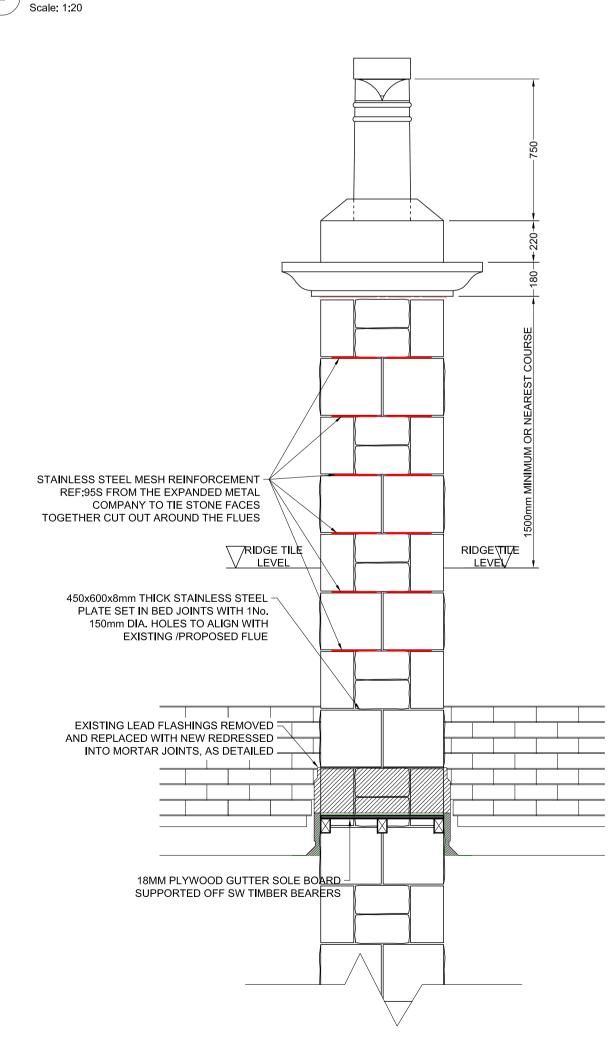



FRONT ELEVATION

Scale: 1:20

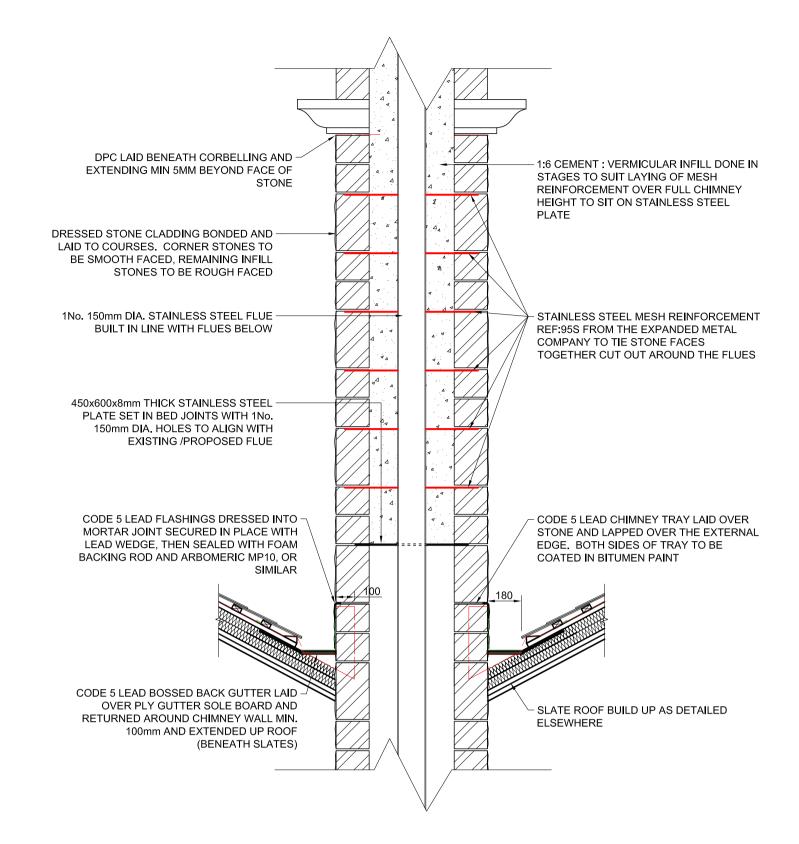


SECTION B-B - THROUGH CHIMNEY BACK GUTTERS

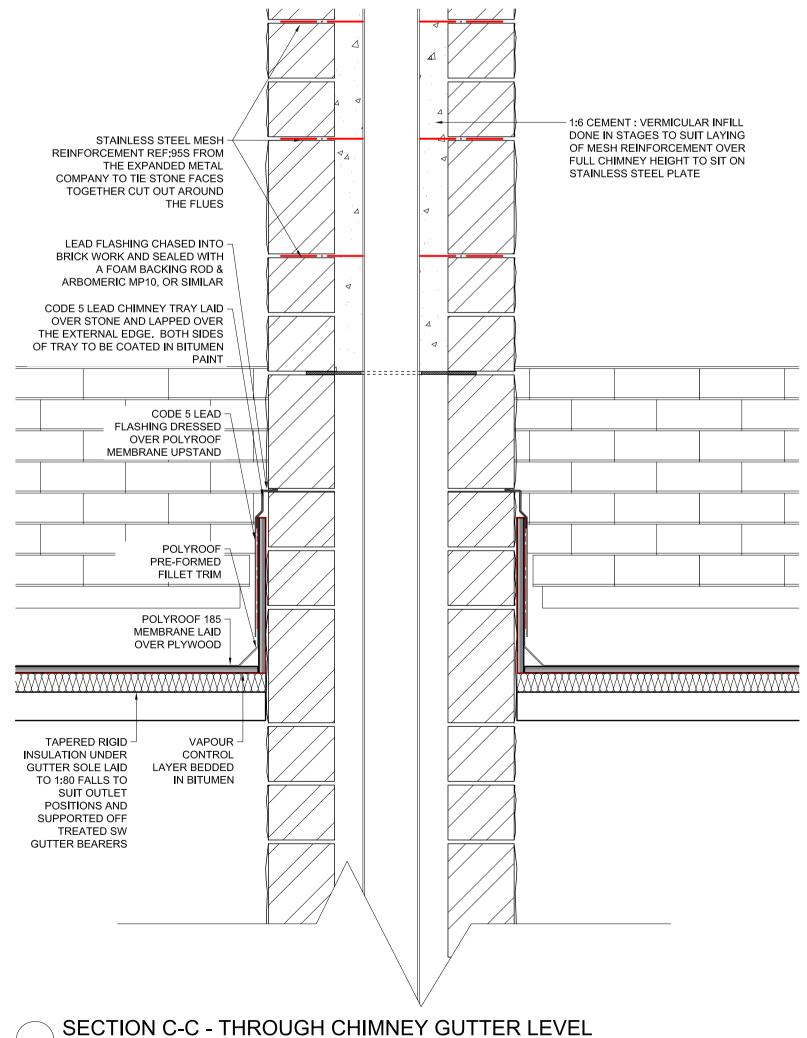

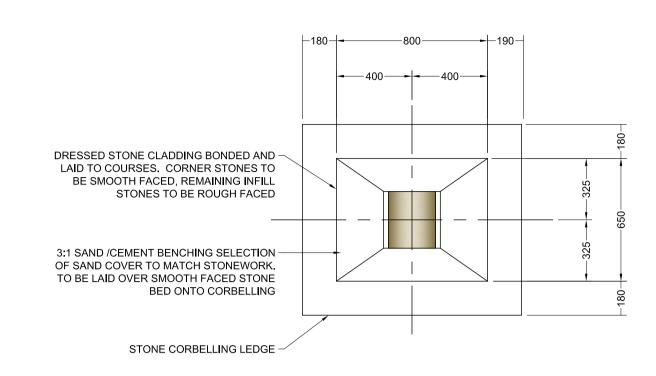

SINGLE CHIMNEY STACK PLAN

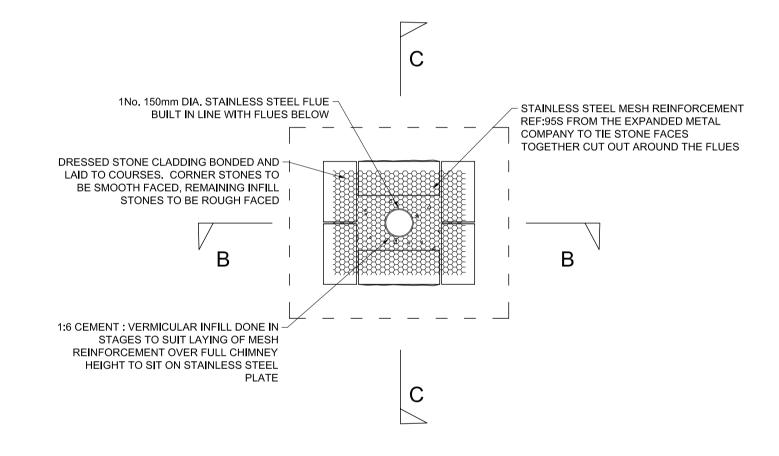

SECTION A-A - THROUGH CHIMNEY STACK

1. SANDSTONE SHALL BE LOCALLY SOURCED AND SHALL BE OF COLOUR, TYPE AND TEXTURE TO MATCH THE EXISTING STONE.

2. STONE TO BE BONDED AND POINTED WITH LIME MORTAR.

3. 100MM THICK LAYER OF GRADE C10 CONCRETE TO BE PLACED ON TOP OF MS PLATES. SAND/CEMENT INFILL SHALL BE PLACED AT LEAST 24Hrs FOLLOWING PLACEMENT OF C10 CONCRETE.

THIS DRAWING IS TO BE READ WITH AND FORMS PART OF THE PROJECT DOCUMENTS LISTED BELOW DOCUMENTS: BDG0069/CIV/NCC NON-COMPLEX DESIGN PACKAGE BDG0069/DRG/A001 EXISTING SITE & LOCATION PLANS EXISTING & PROPOSED ELEVATIONS BDG0069/DRG/A002 GENERAL ARRANGEMENT PLANS BDG0069/DRG/A003 BDG0069/DRG/A004 REPAIR WORKS PLANS EXISTING & PROPOSED TYPICAL SECTIONS BDG0069/DRG/A005 BDG0069/DRG/A006 TYPICAL DETAILS SHEET 1 OF 3 TYPICAL DETAILS SHEET 2 OF 3 BDG0069/DRG/A007 BDG0069/DRG/A008 TYPICAL DETAILS SHEET 3 OF 3 PROPOSED TRIPLE CHIMNEY STACK REPLACEMENT BDG0069/DRG/A009 PROPOSED SINGLE CHIMNEY STACK REPLACEMENT BDG0069/DRG/A010 BDG0069/DRG/E001 ELECTRICAL LAYOUT / DETAILS BDG0061/CIV/SPEC/A01 NBS SPECIFICATION MODEL CLAUSES: NR/L3/CIV/140/10 GENERAL NR/L3/CIV/140/40 DEMOLITION AND SITE CLEARANCE NR/L3/CIV/140/80 STRUCTURAL CONCRETE RT/CE/C/008/150 BRICKWORK, BLOCKWORK & MASONRY RT/CE/C/008/153 BRICKWORK & MASONRY REPAIRS NR/L3/CIV/140/160 GENERAL REQUIREMENTS FOR STRUCTURAL TIMBER NR/L3/CIV/140/161 DESIGN REQUIREMENTS FOR STRUCTURAL TIMBER NR/L3/CIV/140/162 WORKMANSHIP FOR STRUCTURAL TIMBER NR/L3/CIV/140/163 MAINTENANCE AND REPAIR OF STRUCTURAL TIMBER TIMBER PRESERVATION AND FIRE PROTECTION NR/L3/CIV/140/164 NR/L3/CIV/140/170 GENERAL REQUIREMENTS FOR PROTECTIVE TREATMENTS NR/L3/CIV/140/171 MAINTENANCE COATING WORKS NR/L3/CIV/140/173 PROTECTIVE COATING OF EXISTING STRUCTURAL STEELWORK AND IRONWORK PROTECTIVE COATING OF TIMBER SURFACES NR/L3/CIV/140/174 PROTECTIVE COATING OF CONCRETE & MASONRY NR/L3/CIV/140/175 SURFACES


GENERAL NOTES:

NR/L3/CIV/140/176

ALL WORKS TO BE UNDERTAKEN IN ACCORDANCE WITH CURRENT AND APPLICABLE RAILWAY GROUP AND NETWORK RAIL LINE STANDARDS. ALL DIMENSIONS ARE SHOWN IN MILLIMETRES UNLESS NOTED OTHERWISE. USE ONLY DIMENSIONS STATED ON THE DRAWINGS DO NOT TAKE SCALED

PROTECTIVE COATING SYSTEMS

ALL LEAD FLASHING, SOAKERS, STEPPED FLASHING, COVER FLASHING, APRON FLASHING, CHIMNEY FLASHING, PITCHED VALLEYS ETC. TO BE CARRIED OUT IN ACCORDANCE WITH THE LEAD SHEET ASSOCIATION DETAILING.

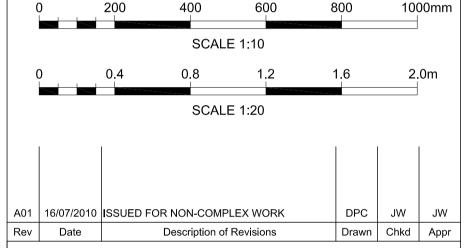

SAFETY HEALTH AND ENVIRONMENTAL INFORMATION

THE HAZARDS AND RISKS ASSOCIATED WITH THE WORKS SHOWN ON THIS DRAWING AND DESCRIBED IN THE SCHEDULE OF WORKS ARE CONSIDERED TO BE WITHIN THE REASONABLE NORMAL AND ACCEPTABLE LIMITS FOR GENERAL BUILDING AND MAINTENANCE WORKS. PLEASE REFER TO DESIGNER RISK ASSESSMENT

DOCUMENT REF: BDG0069/DRA/A01

FOR ISSUE NON COMPLEX WORKS



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Project BDG0069 **BUXTON STATION** DPC/DRY ROT REPAIRS, STATION ROOF & CANOPY ROOF REPAIRS

PROPOSED SINGLE CHIMNEY STACK REPLACEMENT

Designer	A.WADIE	Signed	Date JUI	Y 2010
Drawn	D.CARVER	Signed	Date 14/07/2010	
Checked	J.WILDGOOSE	Signed	Date 15/	07/2010
Approved	J.WINSTANLEY	Signed	Date 16/	07/2010
Scale(s) at A1 Sheet Size A1 594 x 841		ELR & Mileage		
1:10, 1:20		BEJ 19 MILES 9 CHAINS		
Drawing Number				Revision

BDG0069/DRG/A010

A01

Scale: 1:10